

- 1 WINDOW WALL TYPICAL (COLOUR: DARK GRAY)
- GLASS (CLEAR LOW-E) - SPANDRELS AND METAL PANEL WITH INSULATED BACK PANS - DARK GRAY MULLIONS AND HARDWARE
- (2) WINDOW WALL AT PENTHOUSE (COLOUR: SILVER) - GLASS (CLEAR LOW-E)
  - SPANDRELS AND METAL PANEL WITH INSULATED BACK PANS - SILVER MULLIONS AND HARDWARE
- (3) ULTRA HIGH PERFORMANCE CONCRETE (PRECAST CLADDING) - HORIZONTAL RAIL 'BANDS' OFFSET FROM SLAB EDGE
- SMALL VERTICAL FINS AT TOWER LEVELS AND ROOFTOP SCREEN - LARGE VERTICAL FINS BETWEEN CURTAINWALL AT GROUND LEVEL
- (4) WOOD COMPOSITE PANELS EXTERIOR INSULATED - EXTERIOR WALLS & SOFFITS - MINERAL WOOL INSULATION
- (5) CURTAIN WALL AT MAIN ENTRY LOBBY (COLOUR: DARK GRAY) - GLASS (CLEAR LOW-E)
- SPANDRELS AND METAL PANEL WITH INSULATED BACK PANS - MECHANICAL LOUVER VENTS AT VENTILATION SHAFTS
- (6) STRUCTURAL GLASS RAILING - SMALL TOP RAIL - VERTICAL BUTT JOINS
- (7) PAINTED CONCRETE (CAST IN PLACE) - VERTICAL STEEL PICKETS (2x6) - MOUNTED AROUND CONCRETE PLATFORM - FINISHED SILVER
- (8) SOLAR SHADE (METAL) - ANGLED FINS BETWEEN STRUCTURAL 'T' - PENTHOUSE LEVELS
- (9) MECHANICAL ROOFTOP SCREEN (METAL AND UHPC CLADDING) - ULTRA HIGH PERFORMANCE CONCRETE PRECAST VERTICAL FINS - STRUCTURAL STEEL SUPPORT FRAME

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NO.	DATE	DESCRIPTION	BY
1	2018-04-25	ISSUED FOR D.P.	FR

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VANCOUVER BC

V6Z 2L9 CANADA



1551 QUEBEC STREET THE CREEK BUILDING 5

NORTH ELEVATION

3/32" = 1'-0"

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- (1) WINDOW WALL TYPICAL (COLOUR: DARK GRAY)
  - GLASS (CLEAR LOW-E) - SPANDRELS AND METAL PANEL WITH INSULATED BACK PANS - DARK GRAY MULLIONS AND HARDWARE
- 2 WINDOW WALL AT PENTHOUSE (COLOUR: SILVER) - GLASS (CLEAR LOW-E)
  - SPANDRELS AND METAL PANEL WITH INSULATED BACK PANS - SILVER MULLIONS AND HARDWARE
- (3) ULTRA HIGH PERFORMANCE CONCRETE (PRECAST CLADDING) - HORIZONTAL RAIL 'BANDS' OFFSET FROM SLAB EDGE
  - SMALL VERTICAL FINS AT TOWER LEVELS AND ROOFTOP SCREEN - LARGE VERTICAL FINS BETWEEN CURTAINWALL AT GROUND LEVEL
- 4 WOOD COMPOSITE PANELS EXTERIOR INSULATED - EXTERIOR WALLS & SOFFITS - MINERAL WOOL INSULATION
- (5) CURTAIN WALL AT MAIN ENTRY LOBBY (COLOUR: DARK GRAY) - GLASS (CLEAR LOW-E)
- SPANDRELS AND METAL PANEL WITH INSULATED BACK PANS - MECHANICAL LOUVER VENTS AT VENTILATION SHAFTS
- (6) STRUCTURAL GLASS RAILING - SMALL TOP RAIL - VERTICAL BUTT JOINS
- (7) PAINTED CONCRETE (CAST IN PLACE) - VERTICAL STEEL PICKETS (2x6) - MOUNTED AROUND CONCRETE PLATFORM - FINISHED SILVER
- (8) SOLAR SHADE (METAL) - ANGLED FINS BETWEEN STRUCTURAL 'T' - PENTHOUSE LEVELS
- (9) MECHANICAL ROOFTOP SCREEN (METAL AND UHPC CLADDING) - ULTRA HIGH PERFORMANCE CONCRETE PRECAST VERTICAL FINS - STRUCTURAL STEEL SUPPORT FRAME

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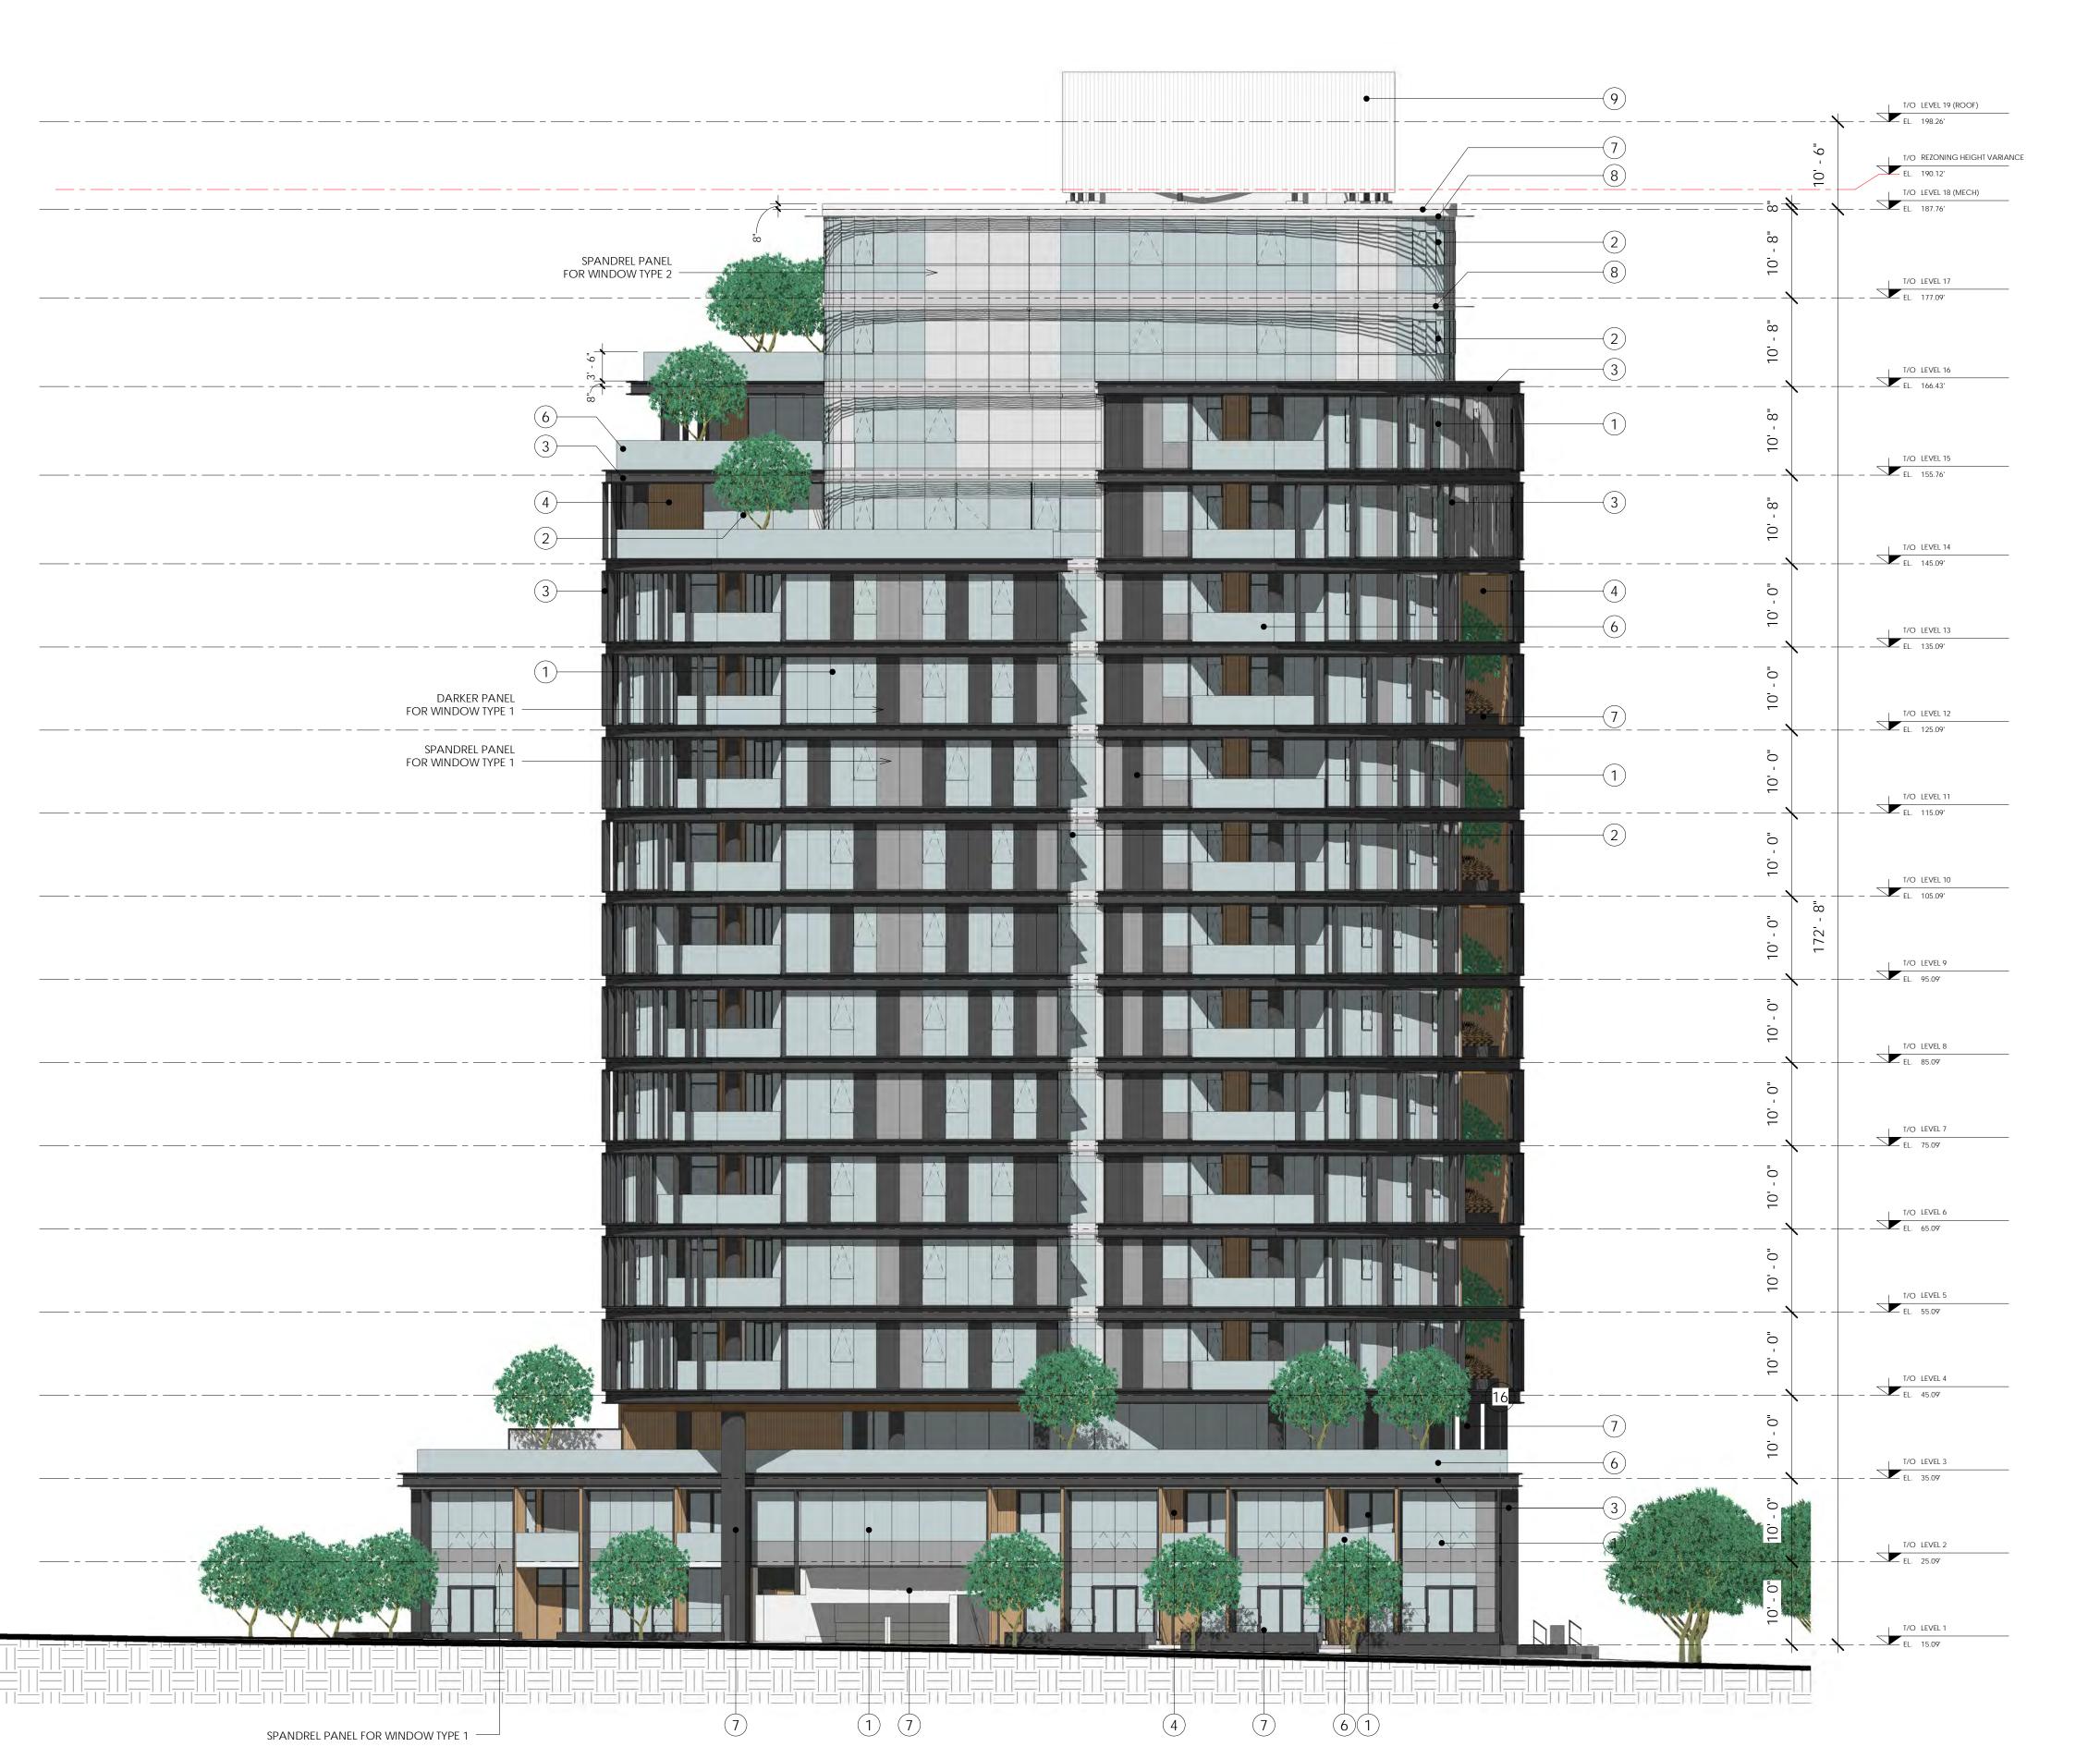
1551 QUEBEC STREET THE CREEK BUILDING 5

EAST ELEVATION

3/32" = 1'-0"

A3-2

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- (1) WINDOW WALL TYPICAL (COLOUR: DARK GRAY)
- GLASS (CLEAR LOW-E) - SPANDRELS AND METAL PANEL WITH INSULATED BACK PANS - DARK GRAY MULLIONS AND HARDWARE
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- (5) CURTAIN WALL AT MAIN ENTRY LOBBY (COLOUR: DARK GRAY) - GLASS (CLEAR LOW-E)
- SPANDRELS AND METAL PANEL WITH INSULATED BACK PANS - MECHANICAL LOUVER VENTS AT VENTILATION SHAFTS
- (6) STRUCTURAL GLASS RAILING - SMALL TOP RAIL - VERTICAL BUTT JOINS
- (7) PAINTED CONCRETE (CAST IN PLACE) - VERTICAL STEEL PICKETS (2x6) - MOUNTED AROUND CONCRETE PLATFORM - FINISHED SILVER
- (8) SOLAR SHADE (METAL) - ANGLED FINS BETWEEN STRUCTURAL 'T' - PENTHOUSE LEVELS
- (9) MECHANICAL ROOFTOP SCREEN (METAL AND UHPC CLADDING) - ULTRA HIGH PERFORMANCE CONCRETE PRECAST VERTICAL FINS - STRUCTURAL STEEL SUPPORT FRAME

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1551 QUEBEC STREET THE CREEK BUILDING 5

SOUTH ELEVATION

3/32" = 1'-0" A3-3

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- 1) WINDOW WALL TYPICAL (COLOUR: DARK GRAY)
  - GLASS (CLEAR LOW-E)
     SPANDRELS AND METAL PANEL WITH INSULATED BACK PANS
     DARK GRAY MULLIONS AND HARDWARE
- 2 WINDOW WALL AT PENTHOUSE (COLOUR: SILVER)
   GLASS (CLEAR LOW-E)
  - SPANDRELS AND METAL PANEL WITH INSULATED BACK PANS - SILVER MULLIONS AND HARDWARE
- ULTRA HIGH PERFORMANCE CONCRETE (PRECAST CLADDING)
   HORIZONTAL RAIL 'BANDS' OFFSET FROM SLAB EDGE
   SMALL VERTICAL FINS AT TOWER LEVELS AND ROOFTOP SCREEN
- SMALL VERTICAL FINS AT TOWER LEVELS AND ROOFTOP SCREEN - LARGE VERTICAL FINS BETWEEN CURTAINWALL AT GROUND LEVEL
- 4 WOOD COMPOSITE PANELS EXTERIOR INSULATED
   EXTERIOR WALLS & SOFFITS
   MINERAL WOOL INSULATION
- 5 CURTAIN WALL AT MAIN ENTRY LOBBY (COLOUR: DARK GRAY)
   GLASS (CLEAR LOW-E)
- SPANDRELS AND METAL PANEL WITH INSULATED BACK PANS
   MECHANICAL LOUVER VENTS AT VENTILATION SHAFTS
- 6 STRUCTURAL GLASS RAILING
   SMALL TOP RAIL
   VERTICAL BUTT JOINS
- 7 PAINTED CONCRETE (CAST IN PLACE)
   VERTICAL STEEL PICKETS (2x6)
   MOUNTED AROUND CONCRETE PLATFORM
   FINISHED SILVER
- 8 SOLAR SHADE (METAL)
   30" DEEP
   ANGLED FINS BETWEEN STRUCTURAL 'T'
   PENTHOUSE LEVELS
- 9 MECHANICAL ROOFTOP SCREEN (METAL AND UHPC CLADDING)
   ULTRA HIGH PERFORMANCE CONCRETE PRECAST VERTICAL FINS
   STRUCTURAL STEEL SUPPORT FRAME

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Project

1551 QUEBEC STREET
THE CREEK BUILDING 5

Drawing Title

WEST ELEVATION

Date:	Project No.
APRIL 2018	11-04-05
Scale: 3/32" = 1'-0"	Drawing No.
Drawn By: FMA	] Δ3-4
File Name: D:\PROJECTS\11-04-05\11-04-05	] / \\