Plant List

key	qty.	Botanical Name	Common Name	Size and Spacing	
		Trees			
AC		Acer circinatum	Vine Maple	B&B, 5cm calliper	
AG		Acer griseum	Paperbark Maple	B&B, 10cm calliper, Tree Form	
APD		Acer palmatum dissectum	Threadleaf Japanese Maple	B&B, 3'h x 4'w specimen	
CS		Cornus 'Starlight'	Starlight Dogweed	B&B, 6cm calliper, 1.2m ht. Sto	
FP		Fraxinus p. Cimmaron'	Ash	B&B, 7cm calliper, 1.8m ht. Sto	
ST1		Street Tree Thurlow	Street Tree	B&B, 7cm calliper, 1.8m ht. Sto	
		Shrubs			
Ag		Azalea 'Gumpo White'	Dwarf Azalea	#5 pot	
Ct		Choisya ternata *	Mexican Orange	#7 pot	
Lp		Lonicera pileata	Boxleaf Honeysuckle	#5 pot	
R1		Rhododendron 'Crete'	Dwarf White Rhododendron	#10 pot	
Т		Taxus media 'Hillii'	Hill's Yew	1.2m ht. B&B	
Vt	÷	Vaccinium o. 'Thunderbird'	Evergreen Blueberry	#5 pot	
		Vines			
-		Clematis cartmanii 'Early Sensa	ition' Evergreen Clematis	#2 pot, staked	
-		Parthenocissus tricuspidata	Boston Ivy	#2 pot, staked	
		Groundcovers, Perennials, Grasses and Ferns			
а		Asarum splendens	Wild Ginger	#1 pot	
as		Astrantia 'Star of Billions'*	Masterwort	#1 pot	
со		Carex 'Everest'	Everest Sedge	#1 pot	
с		Cornus canadensis	Bunchberry	#1 pot	
Ct		Cotoneaster dammeri*	Cotoneaster	#1 pot	
pe		Pennisetum a. 'Hameln'*	Fountain Grass	#1 pot	
pm		Polystichum munitum	Western Sword Fern	#2 pot	
ро	÷	Polygonatum o. 'Variegatum'	False Solomon's Seal	#1 pot	
		Urban Agriculture Tempo			
1-2-2-2-2	1.	Fragaria - everbearing *	Strawberry	#1 pot	
100000		Rubus idaeus 'Chilcotin' *	Raspberry	#3 pot	
1	1.	Vaccinium 'Northland'*	Dwarf Blueberry	#3 pot	

Landscape Bird Friendly Strategy

There are several landscape measures to ensure the proposed development is Bird Friendly. The existing retained street trees along Burnaby Street will provide canopy cover and mature habitat. Additionally the new street tree planting in the City boulevard on Thurlow Street will provide more habitat opportunites and also continue to provide a continuous forest canopy for birds.


The proposed landscape planting incorporates canopy/habitat stratification with tree and shrub planting, utilizes plants that attract birds and insects, and includes native and non-native/non-invasive plants. The townhouse rooftops along the lane are planted with an extensive green roof.

The proposed area of exterior green space for the building significantly exceed the existing green coverage on the site. The planting is distributed over two levels of the building with different exposures - the market level with north and eastern exposures, and the social housing with a south and western exposure.


General Planting Notes:

- All work shall meet or exceed the requirements as outlined in the Current Edition of the B.C. Landscape Standard. Plant sizes and related container classes arespecified according to the B.C. Landscape Standard Current Edition. For container classes #3 and smaller, plant sizes shall be as shown in the plant list and the Standard: for all other plants, both plant size and container class shall be as shown in the plant list. Specifically, when the plant list call for #5 class containers these shall be as defined in the BCNTA (ANSI) Standard.
- (Ansu)) standard. Sod is to be sand based turf and mesh free. No substitues. All soft landscape area are to be irrigated using a high efficiency drip system, complete with rain sensor. All work to IIABC standards. Atlach vines to trellis posts using non-chafing garden twine. All plants with an asterisk (*) are bird friendly species.



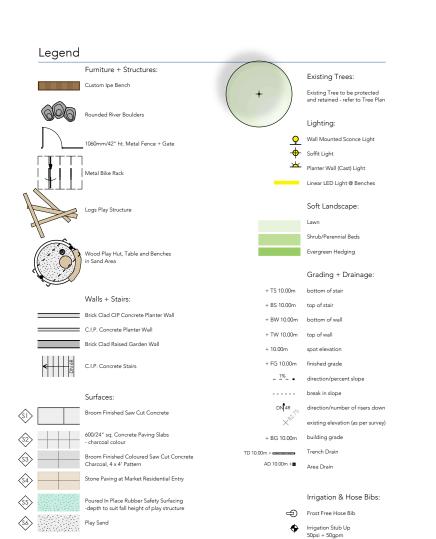


4.2 Tree Retention on Boulevards Adjacent to Construction Sites Boulevard trees adjacent to construction sites, including those of less than 20 cm diameter, must be protected in accordance with these Engineering Department guidelines and cannot be pruned, moved or otherwise disturbed without prior written Park Board permission.

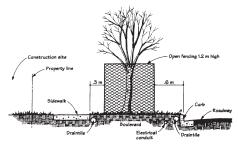

Barrier fencing used for tree protection must: a) allow for free and clear passage of pedestrians on the sidewalk and adjacent portion of boulevard; b) provide for clear visibility of fire hydrants, driveway access, crosswalks, etc. ("see-through" fencing should be used);

a) be 0.6 m or more from the curb to provide for the opening of car doors; and
 b) be 0.3 m or more from the edge of any sidewalk located within a grass boulevard.

NOTE: These setbacks also reduce the possibility of interference with underground utilities when staking fences in place

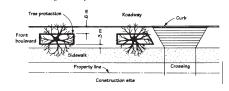

Note: no storage of building materials within or against protection barrier Tree Retention Guideline

nimum outside of branches (dripline)

4.1 Tree Retention

Where trees are to be retained on a site, protection barriers must be installed as specified in the Private Property Tree By-law.
Any required excavation in or around the protection barrier to accommodate underground services, footings, etc. should be indicated on the plan and done by hand.
Trees inside the protection zone should be careford for throughout the construction process, i.e., they must be watered sufficiently, particularly if a portion of the tree's root system has been disturbed by excavation.

a fere

solid barrier (2" x 4")-

plastic mesh screening

excavation. d) Root and branch pruning, where necessary, must be done in accordance with Sections 4.4 and 4.5. Only the Park Board is authorized to prune trees on City property.

Ld - 1 City of Vancouver Tree Protection Barrier Detail Not To Scale 1.2

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no.: | date: Revisions:

1 2018.11.23 Issued for Rezoning item:



Proiect:

1290 Hornby Street Vancouver BC

Drawn by:	JES
Checked by:	JES
Date:	2018.10.03
Scale:	1/8"=1'-0"

Drawing Title:

Landscape Legends + Lists

Project No.: 18038

Sheet No.:

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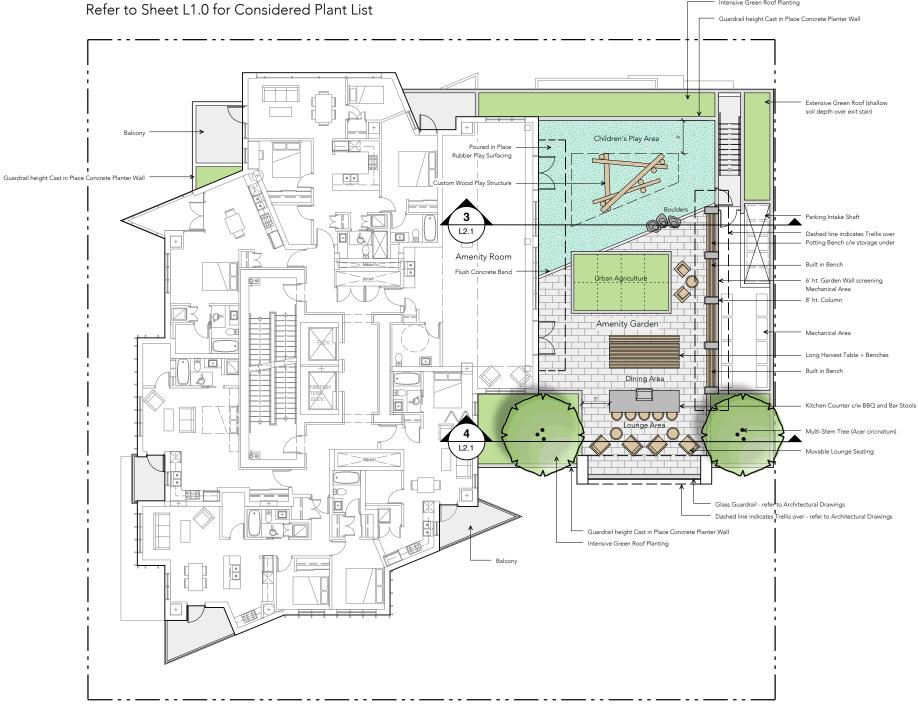
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Intensive Green Roof Planting



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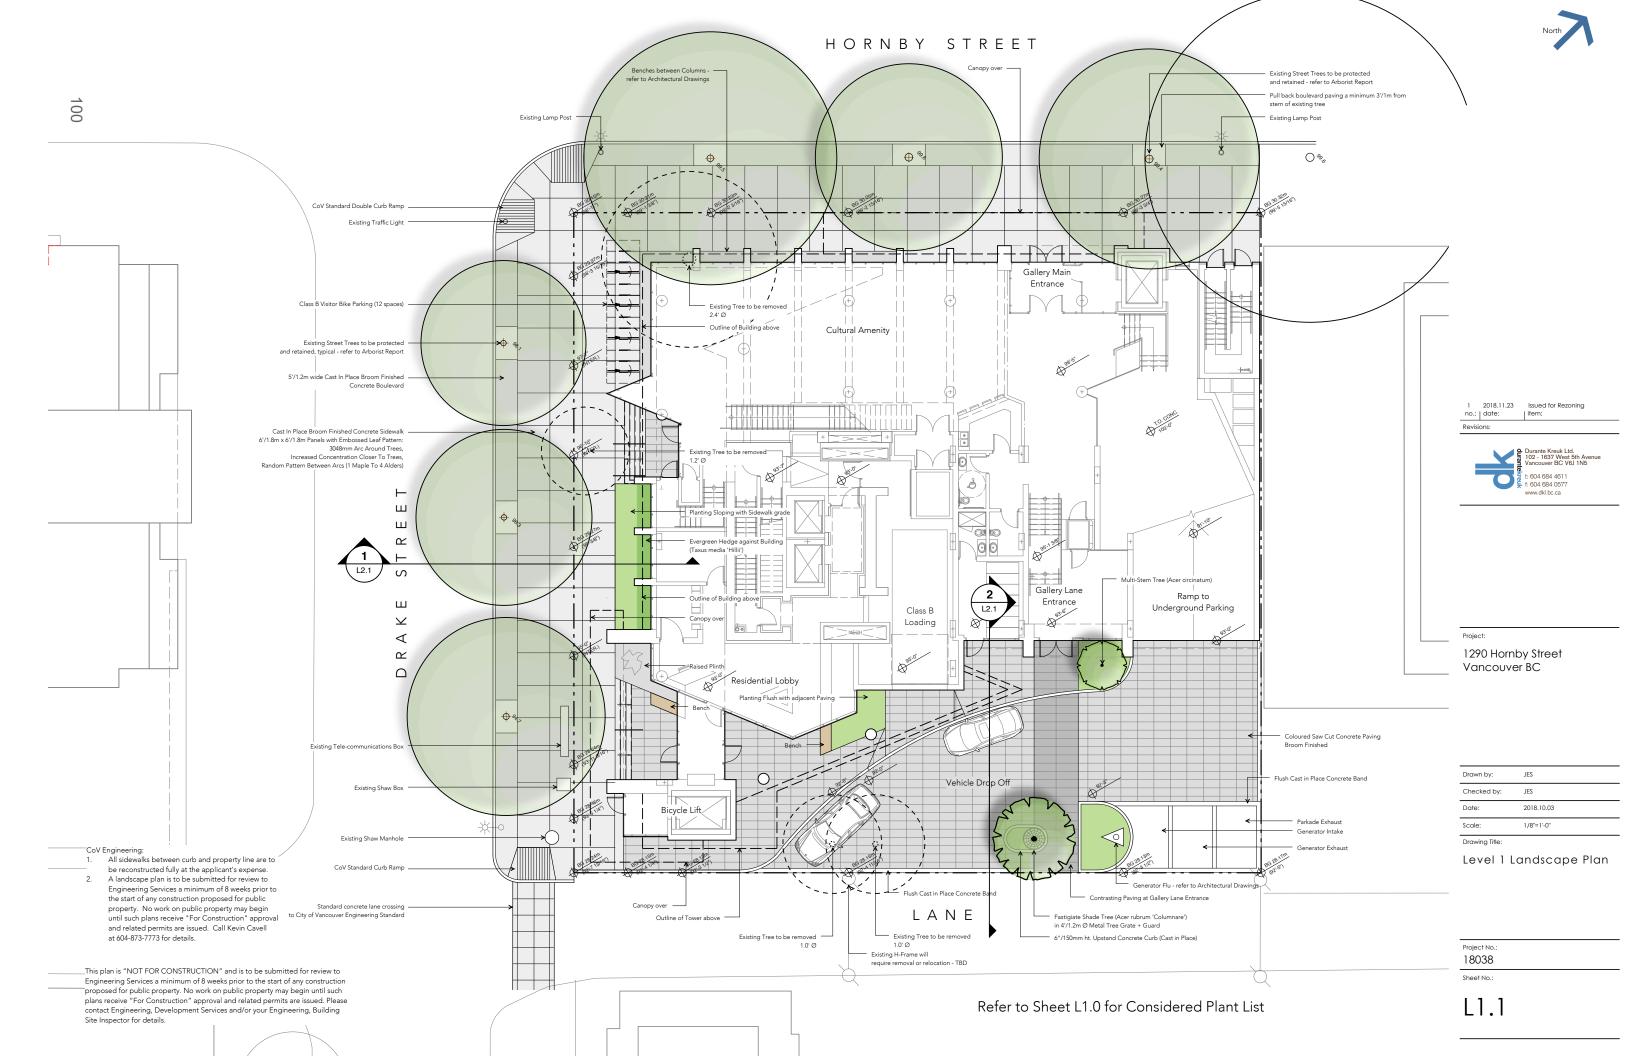
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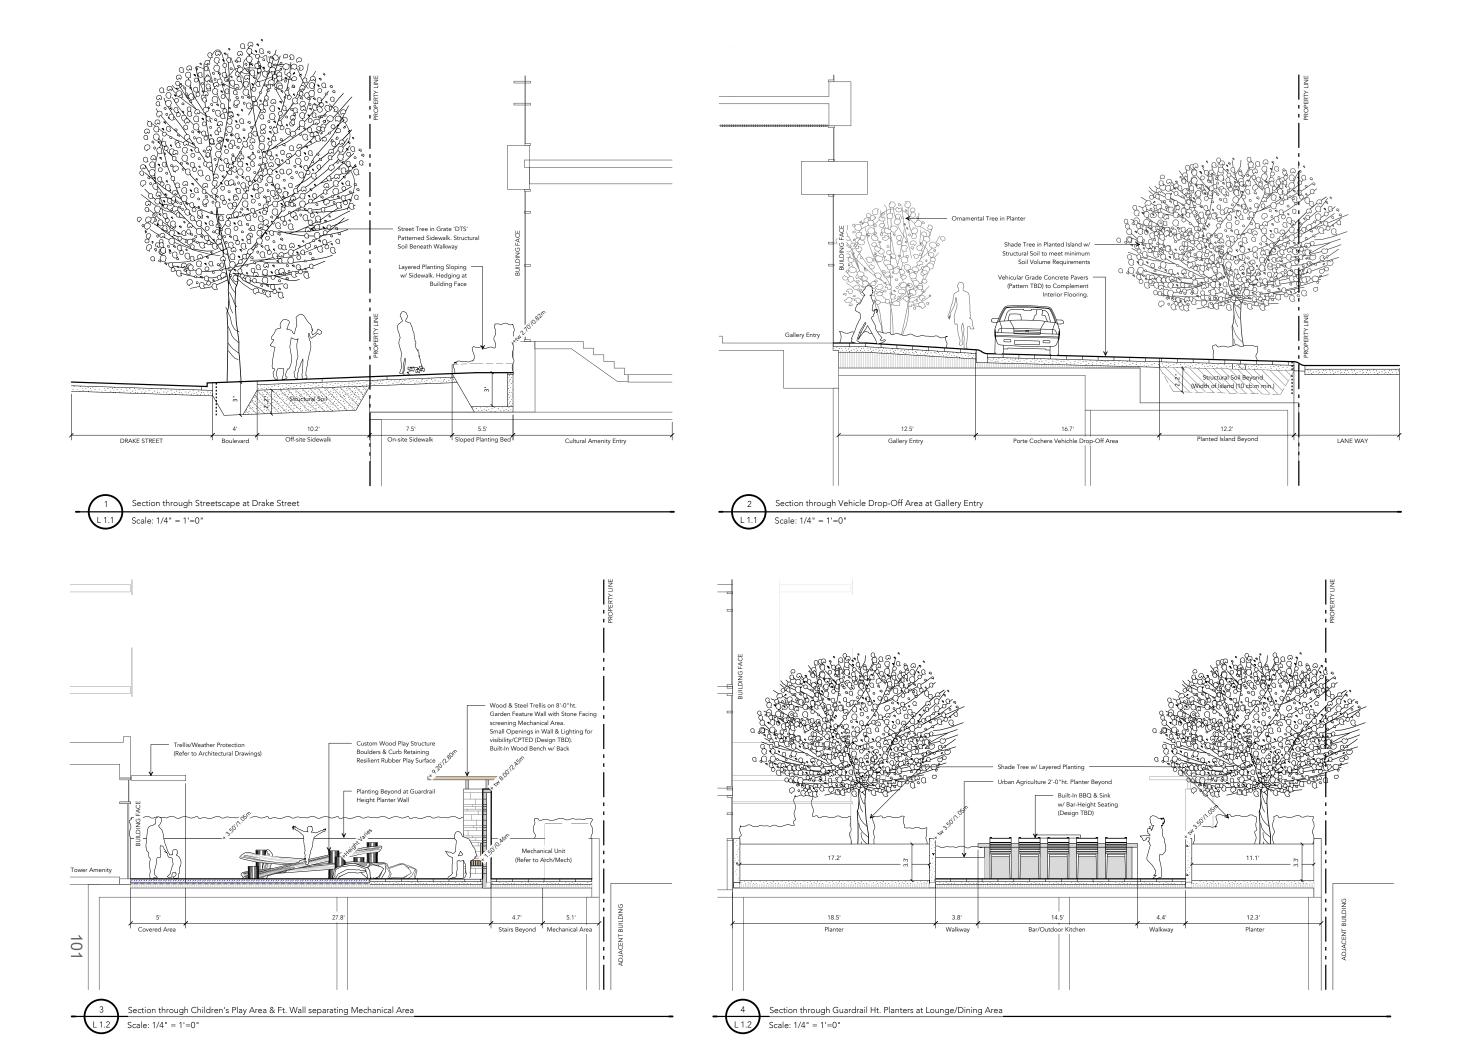
Level 6 Landscape Plan

Project No.: 18038

Sheet No.:

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1 2018.11.23 Issued for Rezoning no.: | date: | item: Revisions:



Proiect:

1290 Hornby Street Vancouver BC

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Scale:	1/4"=1'-0"

Drawing Title:

Landscape Sections

Project No.: 18038

Sheet No.:

L2.1