RESIDENCE FOR:

PATRICIA HEIGHTS RENOVATION

JOB # 019-143

LOT:

8

BLOCK:

5

PLAN:

5405NY PATRICIA HEIGHTS

SUBDIVISION: ADDRESS:

15719 - 784 AVENUE

MAIN FLOOR:

119

ADDITION AREAS:

SQFT

SECOND FLOOR: TOTAL: 539 658 SQFT SQFT

GARAGE:

608

SQFT

All sizes, dimensions & construction details to be verified by general contractor/builder prior to any construction.

Discrepancies to be reported to THE BUILDER

& clarification agreed upon before proceeding with any work

DRAWN BY - CM

REVISIONS:

DATE:

DATE:

DATE:

PRINT DATE: March-25-20

DATE:

TOTAL MAIN FLOOR:1295SQFTTOTAL SECOND FLOOR:539SQFTTOTAL BASEMENT:967SQFTTOTAL FINISHED AREAS:2801SQFTTOTAL GARAGE:608SQFT

GENERAL CONSTRUCTION NOTES:

- All work to conform with the current edition of the Alberta Building Code and local bylaws.
- All footings to rest on undisturbed soil.
- Weeping tile to be installed around entire perimeter of strip footings and tied to drainage system according to local bylaws.
- Engendered lumber and floor systems to be installed to manufacturers specifications.
- All roof truss systems are to be engineer approved by others.
- Provide all cantilever floor joists with R28 insulation, C.G.S.B. app. vapor barrier to warm side and 1/2" aupsum to u/s c/w metal soffit to spec.
- Contractor shall verify all Micro lam, LVL, PSL and/or Glulam beam sizes with engineer.
- All common house/garage walls, ceilings and floors to be min. ONE HOUR firerated and gas proofed.

- Attic access to be 22" x 28" c/w weather stripping and insulation.
- Window sizes indicated are approx. frame size, unless noted otherwise. Verify all window R.O. sizes, styles and types with owner and supplier prior to any ordering or installation of windows.
- Parging shall conform with the current edition of the Alberta Building Code.
- Provide smoke/co detector(s) as required by code.
- Dryer vent to be 4" c/w hood and screen.
- All electrical to conform with the current edition of the Alberta Building Code.
- Mechanical all HYAC shall conform with the current edition of the Alberta Building Code.
- All plumbing to conform with the current edition of the Alberta Building Code.
- Stair Detail Notes:

Rise = Max. 8" Run = Min. 10" Tread = Min. 11 1/4"

Guardrail height (landings) = Min. 36"

Handrail height @ 32" to 36"

Headroom = Min. 6'-6"

- Provide roof vents as required by code.
- Provide flashings to all roof valleys, all roof penetrations and step flashing as required.
- Provide insulation stops.
- Provide prefinished eavestroughing on pre-finished fascia c/w eaves protection.
- Provide flashing above all windows and doors.
- Grades as shown are for reference only, actual grading plan to be determined by Surveyor.

 Adjust all steps to suit site.
- All above grade masonry shall conform with the current edition of the Alberta Building Code.
- Provide min. 8" clearance from grade to wood construction.
- Main floor height to garage slab height dimension is to be verified by Surveyor with actual grades on site.
- Shower doors to be tempered glass.



CARRIATURE HOMES LTE






EXISTING FRONT ELEVATION

SCALE 1/8" = 1'-0"




EXISTING REAR ELEVATION

SCALE 1/8" = 1'-0"

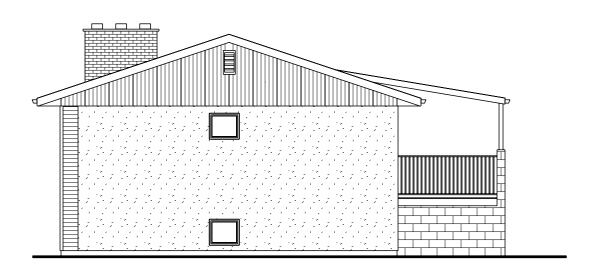


EXISTING RIGHT SIDE ELEVATION

SCALE 1/8" = 1'-0"

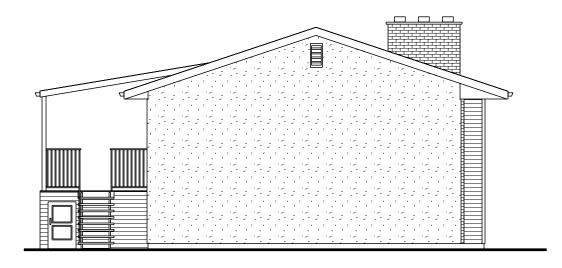


EXISTING LEFT SIDE ELEVATION

SCALE 1/8" = 1'-0"

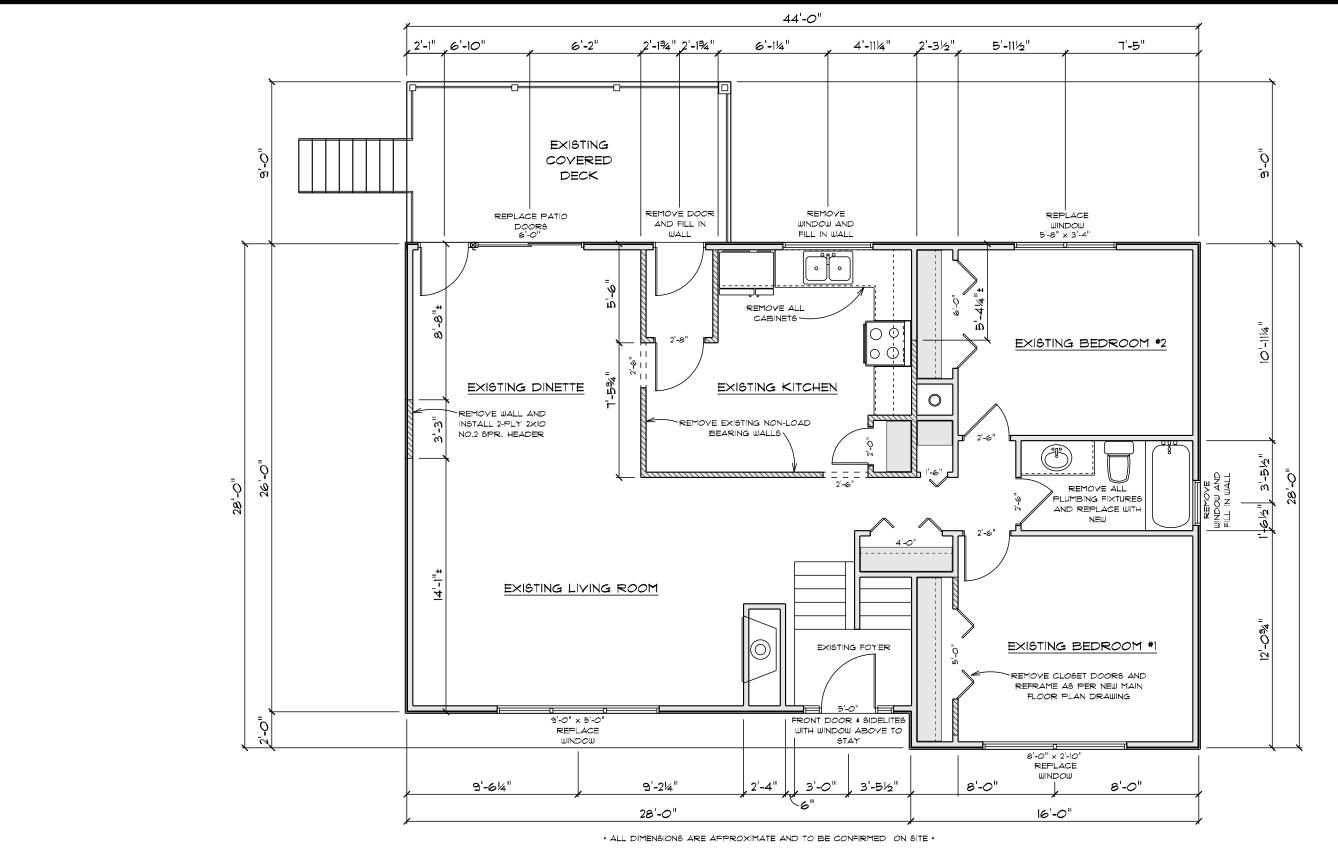


EXISTING MAIN FLOOR PLAN

SCALE: 3/16" = 1

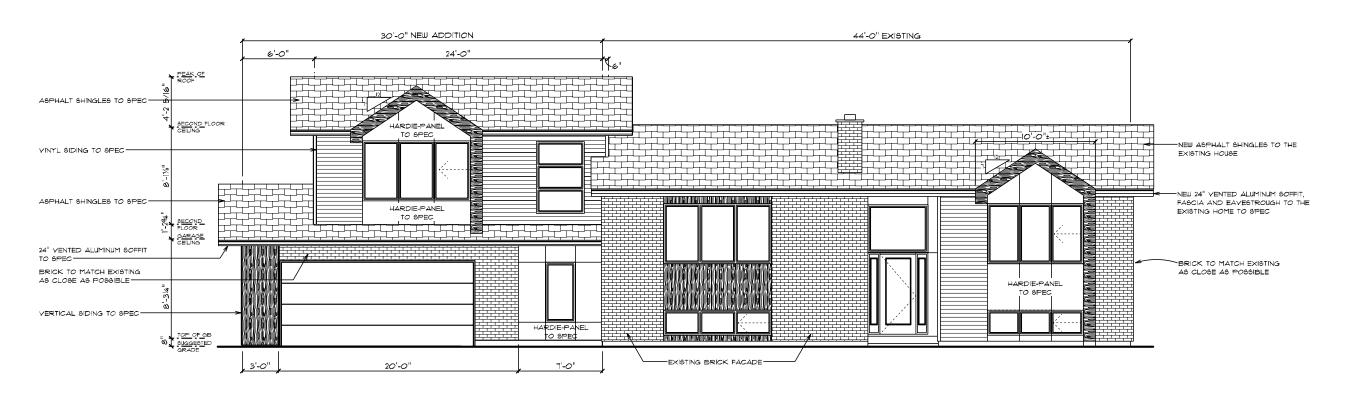



NEW FRONT ELEVATION


SCALE 1/8" = 1'-0"

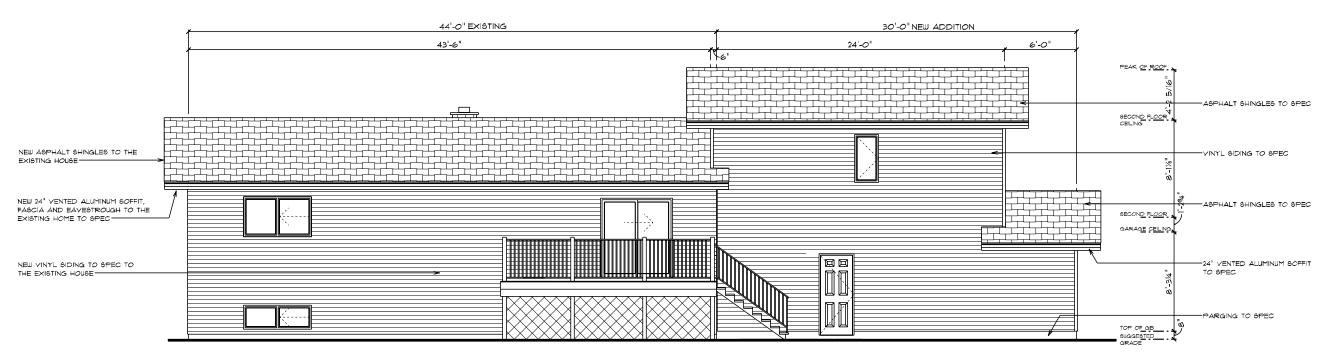



NEW REAR ELEVATION SCALE 1/8" = 1'-0"

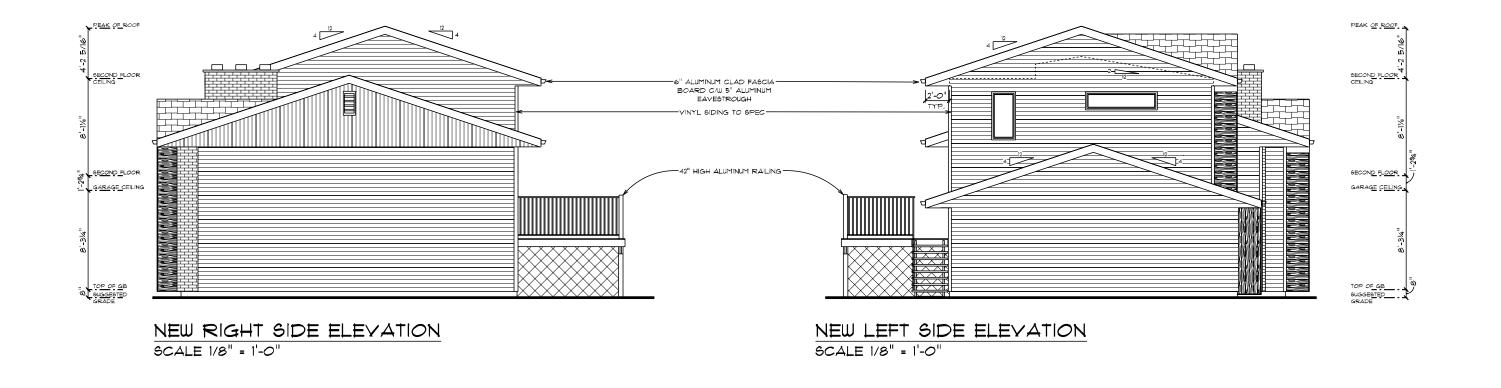

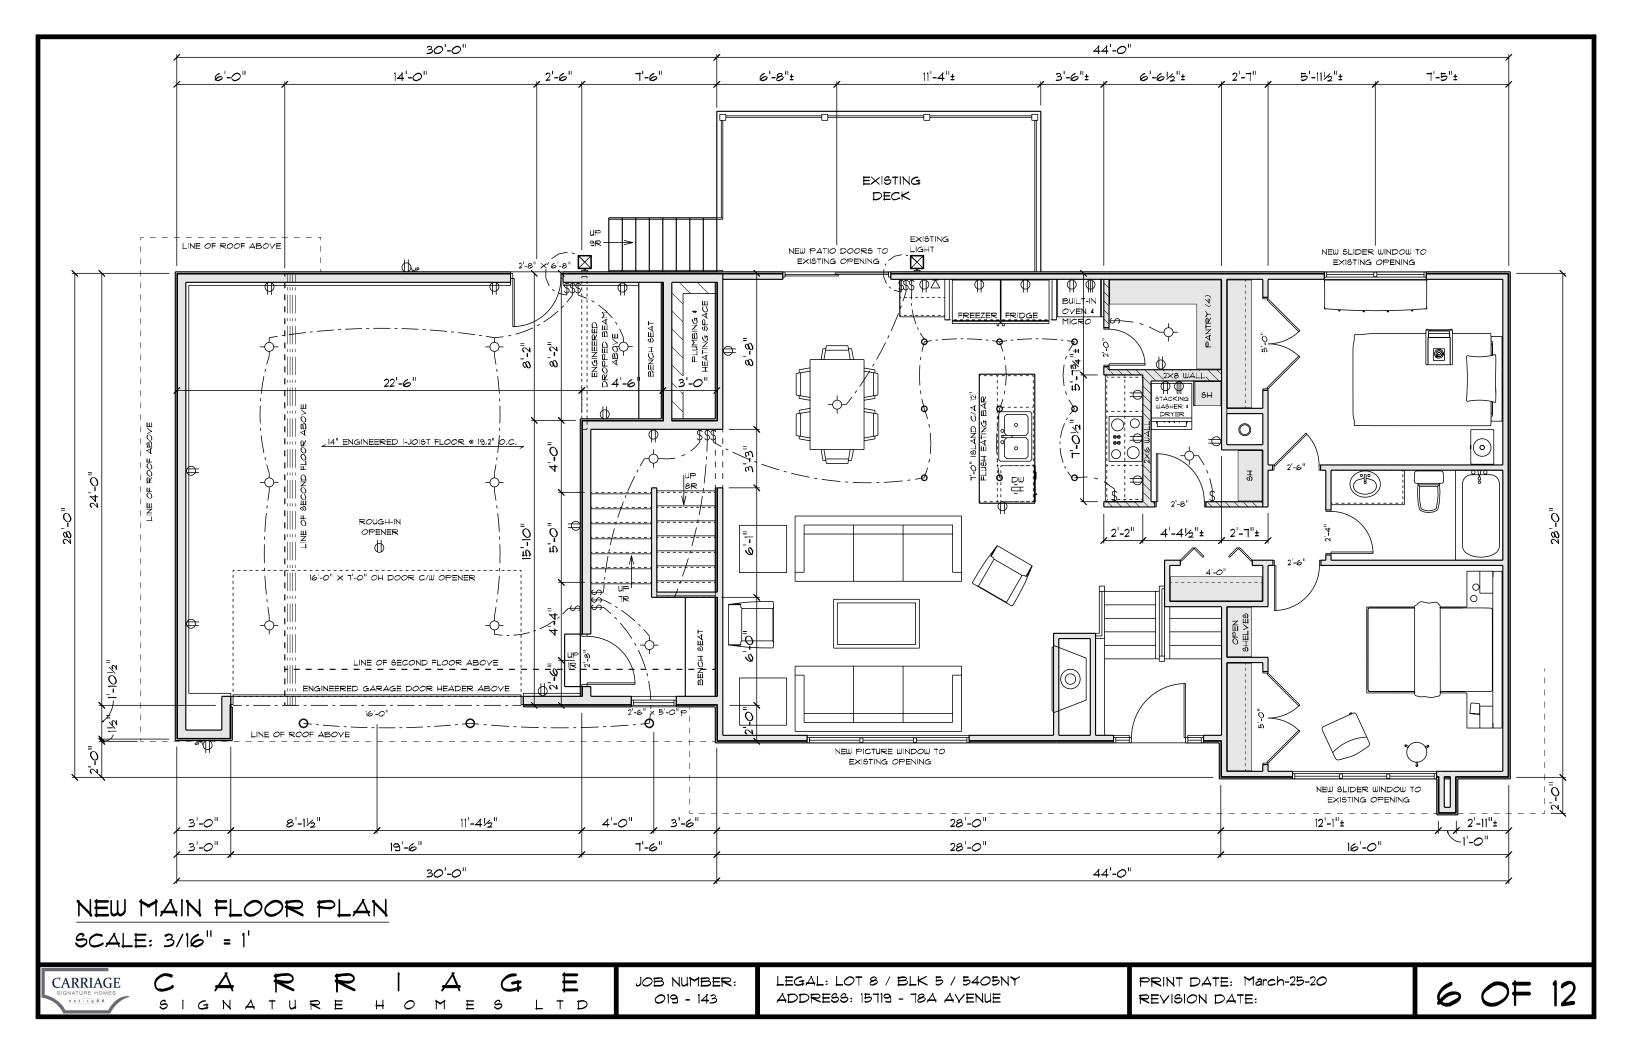

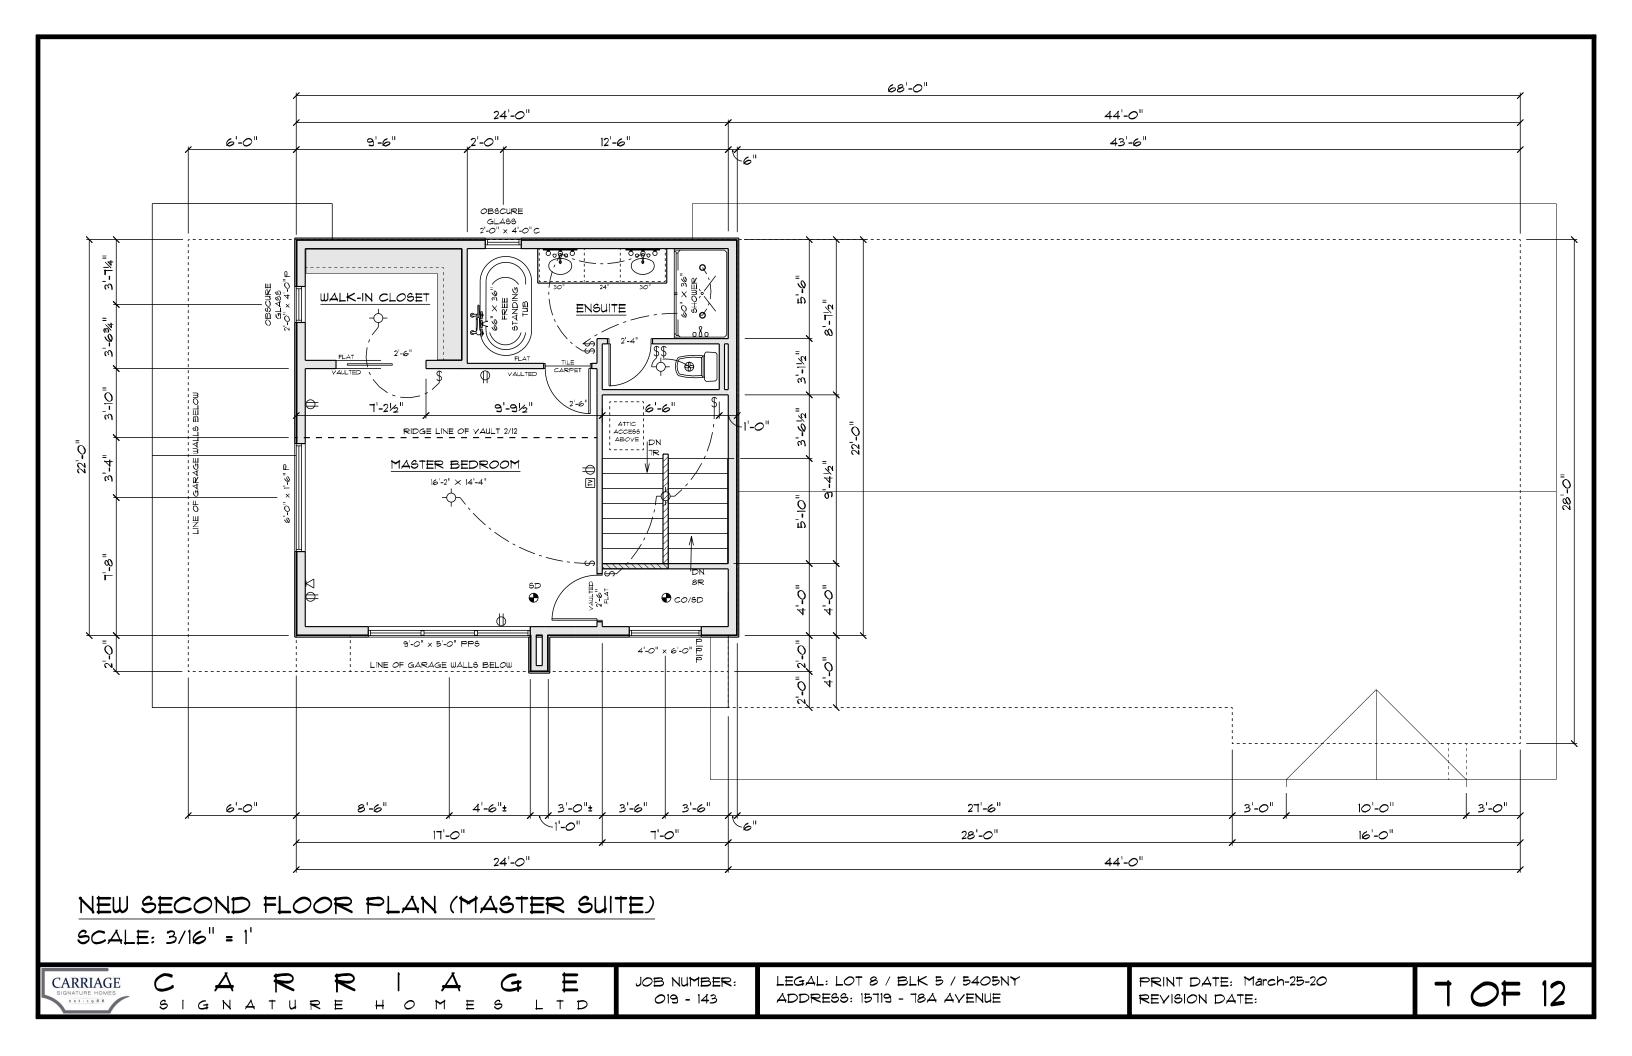


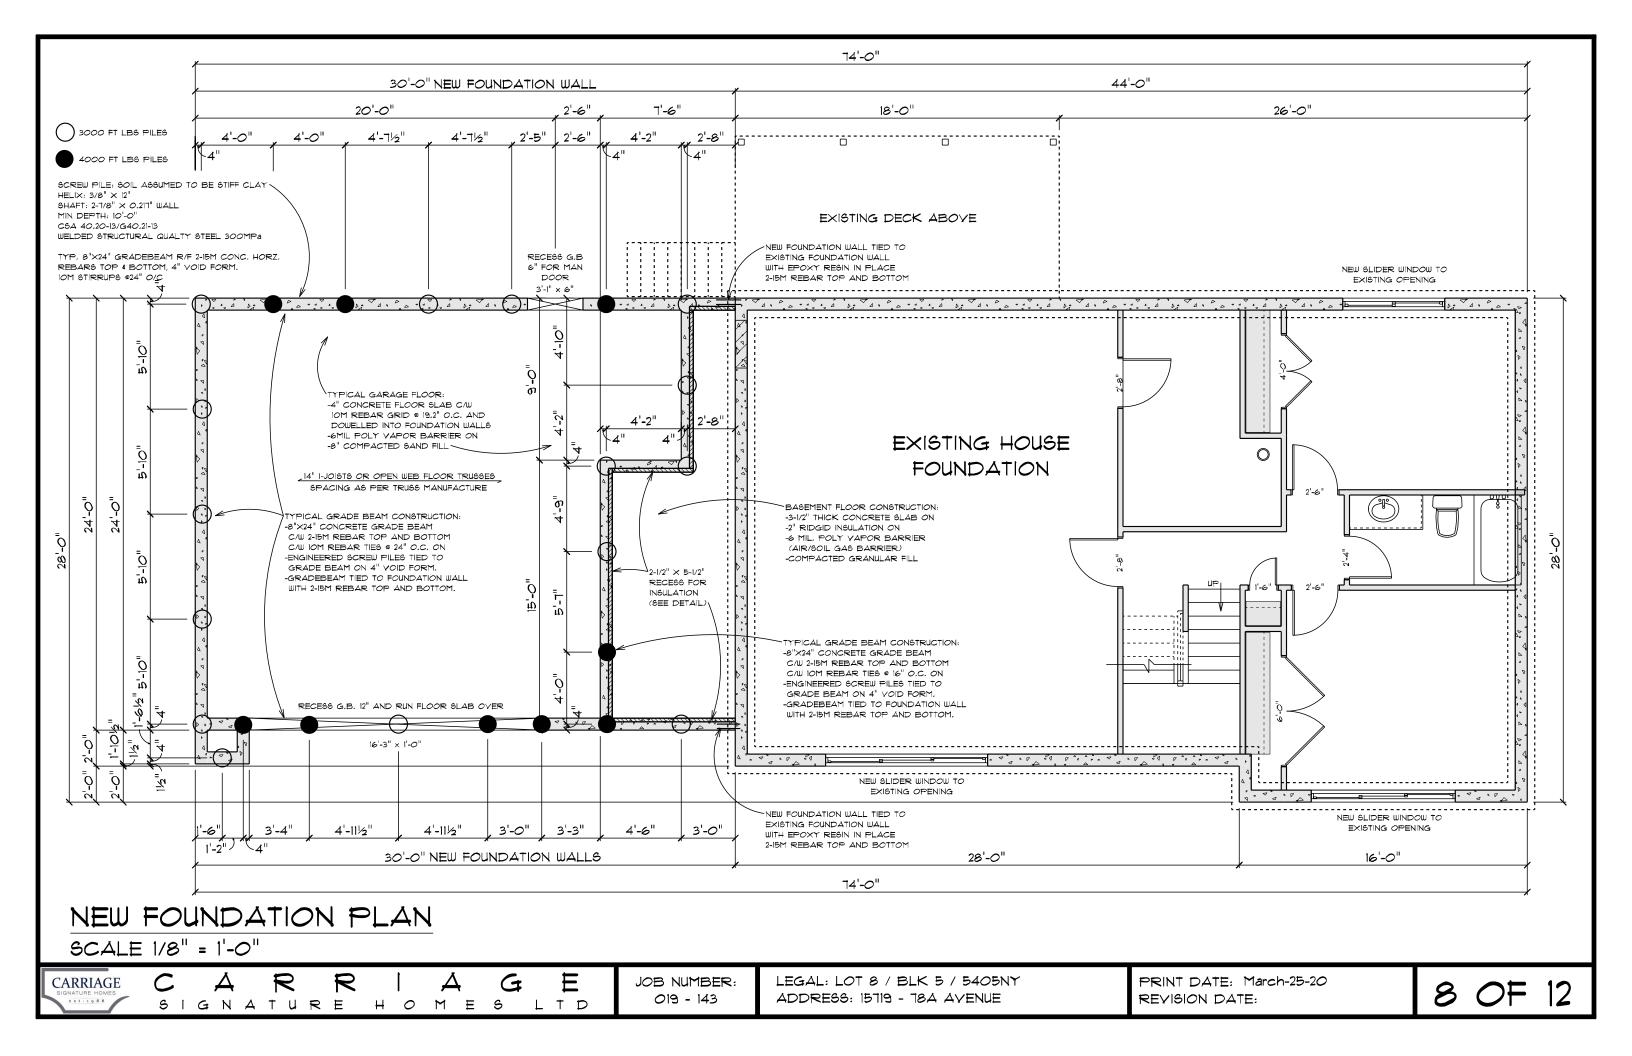

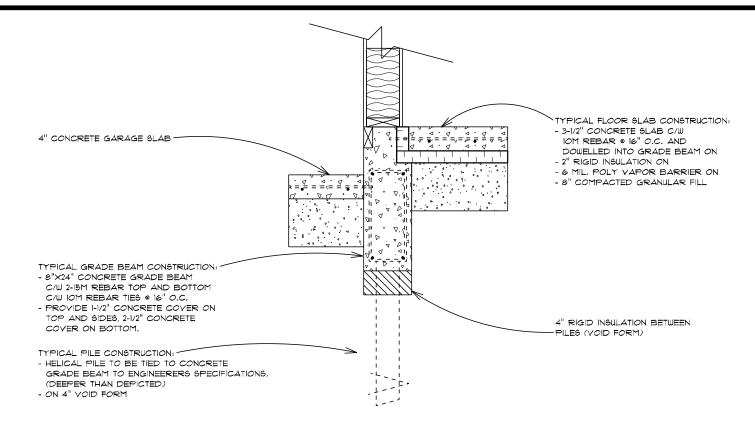


GARAGE / HOUSE INTERIOR GRADEBEAM DETAIL

SCALE: 3/4"=1'-0"

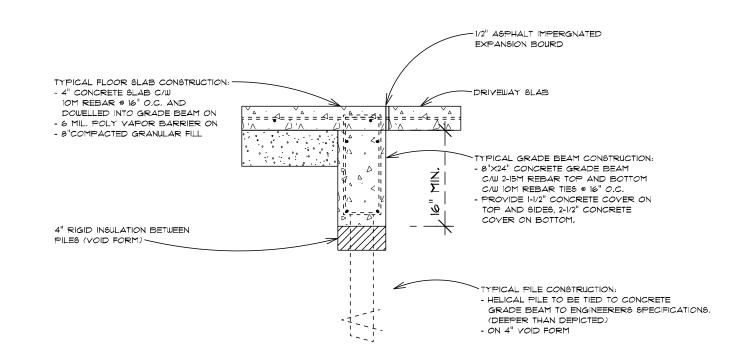

GARAGE GRADEBEAM / DOORWAY DETAIL SCALE: 3/4"=1'-0"

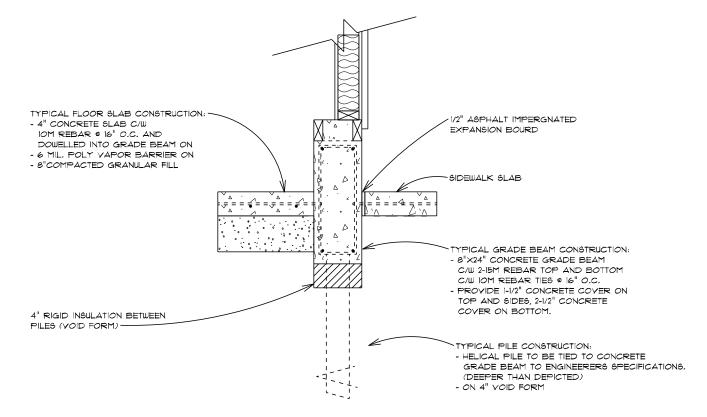

GARAGE EXTERIOR GRADEBEAM DETAIL

SCALE: 3/4"=1'-0"

CARRIAGE
SIGNATURE HOMES
e s t · 1 9 8 8

CARRIAGE SIGNATURE HOMES LTD JOB NUMBER: 019 - 143

LEGAL: LOT 8 / BLK 5 / 5405NY ADDRESS: 15719 - 784 AYENUE PRINT DATE: March-25-20 REVISION DATE:

9 OF 12

TYPICAL ROOF CONSTRUCTION:
-ASPHALT SHINGLES ON
-3/8" OSB ROOF SHEATHING C/III 'LI'

-3/8" OSB ROOF SHEATHING C/W 'H' CLIPS ON -PRE-ENGINEERED TRUSSES @ 24" O.C. C/W 2X4 TRUSS BRACING OR AS REQUIRED BY TRUSS MANUFACTURER.

-R60 BLOWN-IN CELLULOSE INSULATION -6 MIL POLY VAPOR BARRIER -1/2" CD CEILING DRYWALL

-TAPED & SANDED C/W CEILING TEXTURE

TYPICAL EXTERIOR WALL CONSTRUCTION:
-EXTERIOR FINISH AS PER ELEVATIONS
-EXTERIOR WEATHER/AIR BARRIER
-3/8" OSB SHEATHING
-2x6 STUDS @ 16" O/C
-R22 BATT INSULATION
-6 mil POLY V.B.
-1/2" DRYWALL
-TAPED & SANDED

TYPICAL FLOOR CONSTRUCTION:
-FLOOR FINISHED AS SPECIFIED ON
-3/4" T&G FIR PLYWOOD SUBFLOOR,
SCWEWED & GLUED TO THE JOISTS,
-14" DEEP ENGINEERED APPROVED I-JOIST
FLOOR SYSTEM @ 19.2" O.C. C/W BRACING
OR AS REQUIRED BY TRUSS SUPPLIER,

TYPICAL INTERIOR WALL CONSTRUTION: -2×4 OR 2×6 STUDS @ 16" O.C -1/2" DRYWALL BOTH SIDES -TAPED & SANDED

TYPICAL HOUSE GRADE BEAM CONSTRUCTION:
-8"X24" CONCRETE GRADE BEAM

C/W 2-15M REBAR TOP AND BOTTOM

C/W 10M REBAR TIES @ 16" O.C. ON
-ENGINEERED SCREW PILES TIED TO

GRADE BEAM ON 4" VOID FORM.
-GRADEBEAM TIED TO FOUNDATION WALL

WITH 2-15M REBAR TOP AND BOTTOM.
-PARGING ABOVE GRADE AND ASPHALT

DAMPPROOFING BELOW GRADE ON BOTH


SIDES OF WALL.
-2X4 STUD WALL @ 16" O.C. PULLED 6" AWAY
FROM THE FOUNDATION WALL WITH R20 BATT

INSULATION AND 6 MIL POLY VAPOR BARRIER.

TYPICAL GARAGE GRADE BEAM CONSTRUCTION:
-8"X24" CONCRETE GRADE BEAM
C/W 2-15M REBAR TOP AND BOTTOM
C/W IOM REBAR TIES @ 16" O.C. ON
-ENGINEERED SCREW PILES TIED TO
GRADE BEAM ON 4" YOID FORM.
-GRADEBEAM TIED TO FOUNDATION WALL
WITH 2-15M REBAR TOP AND BOTTOM.

TYPICAL GARAGE FLOOR:
-4" CONCRETE FLOOR SLAB C/W
10M REBAR GRID @ 19.2" O.C. ON
-8" COMPACTED SAND FILL


BASEMENT FLOOR CONSTRUCTION:
-3-1/2" THICK CONCRETE SLAB ON
-6 MIL. POLY YAPOR BARRIER
(AIR/SOIL GAS BARRIER)
-COMPACTED GRANULAR FILL

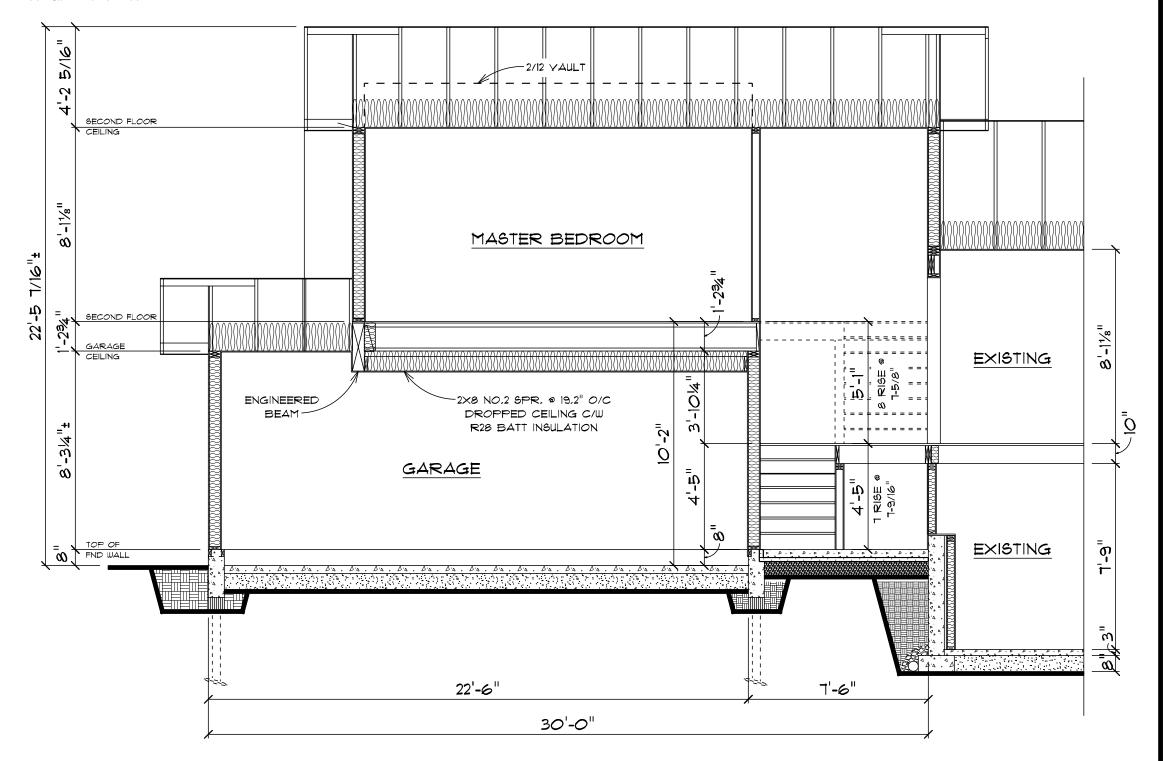

CROSS SECTION

SCALE: 1/4" = 1'



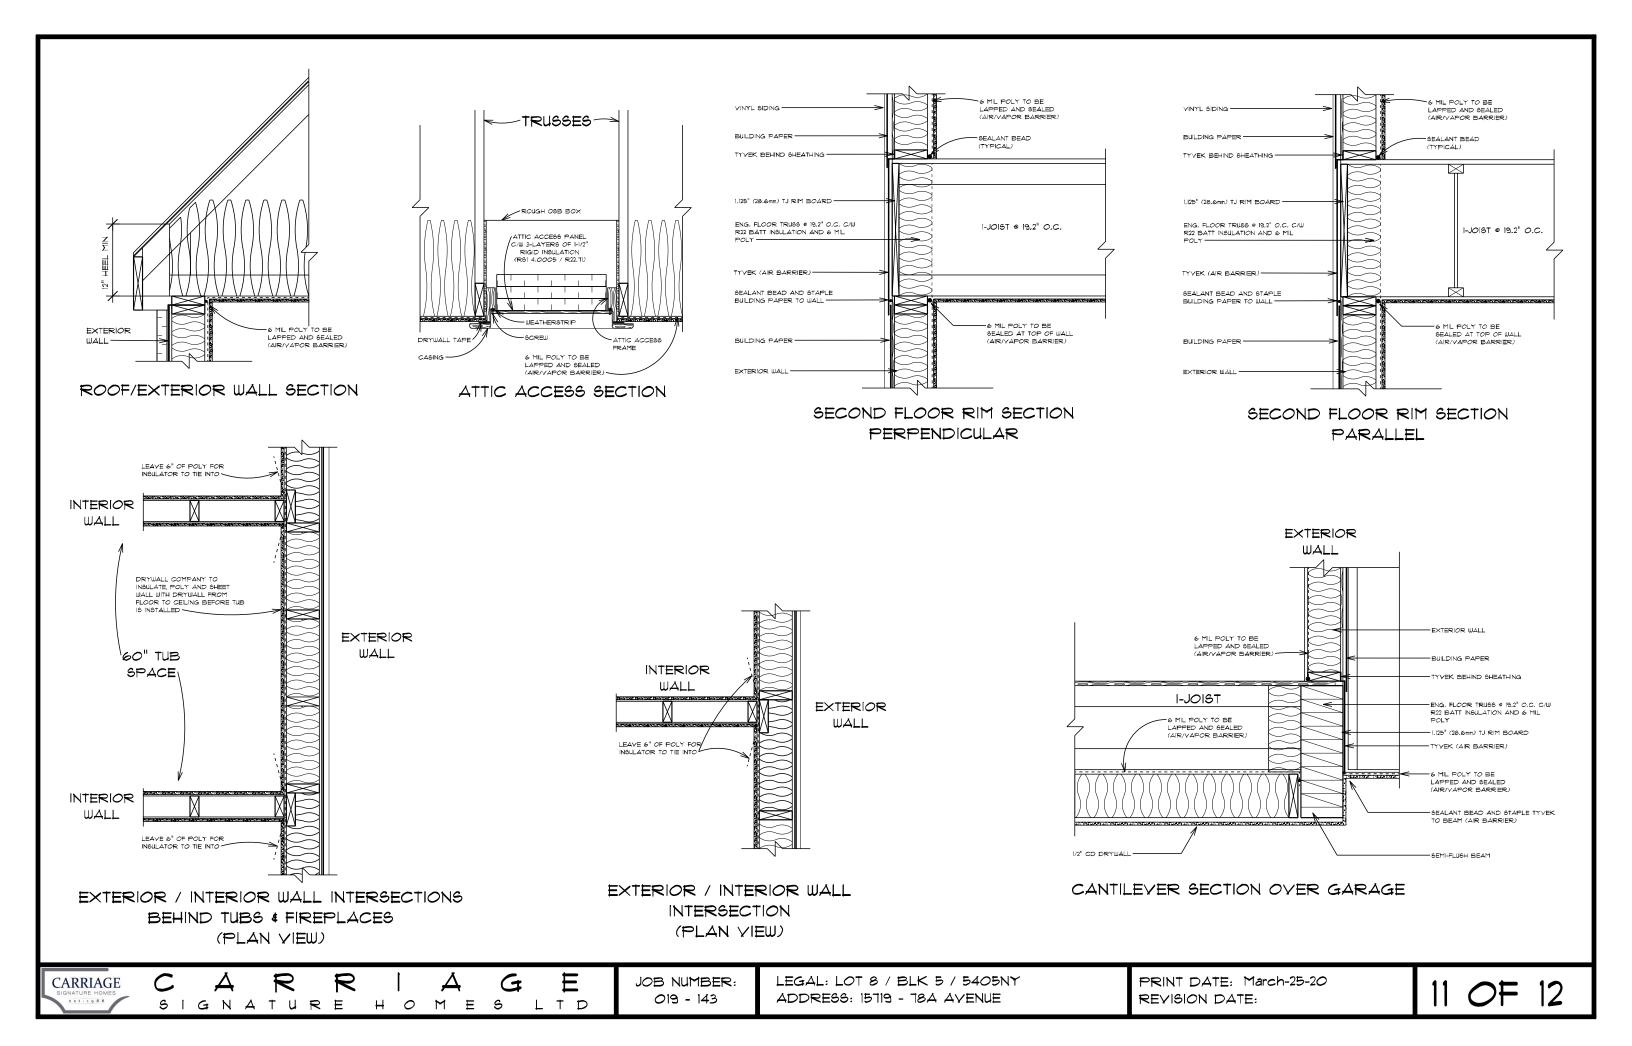

9.36.2.6.B

EFFECTIVE THERMAL RESISTANCE OF ABOVE GROUND OPAQUE ASSEMBLIES IN BUILDINGS WITH OUT A HEAT RECOVERY VENTILATOR.

EFFECTIVE RSI VALUES (NO HRV)

HEATING DEGREE DAYS EDMONTON CLIMATE ZONE (1)A

CELLINGS BELOW ATTICS | 0.43 | 59.23 | CATHEDRAL CELLINGS | 5.02 | 28.51 | WALLS (2X6 e 16*) | 3.06 | 11.49 | 11.0078 | 0.078 | M. |

'NOTE'

MINIMUM REQUIREMENTS WITH-OUT A HEAT RECOVERY VENTILATOR

9.36.2.T.A

REQUIRED THERMAL CHARACTERISTICS OF FENESTRATION AND DOORS.

HEATING DEGREE DAYS EDMONTON CLIMATE ZONE (T)A

MAX, UVALUE W/(M2,K)
MIN. ENERGY RATING

